

LIST OF ASSEMBLIES:

WINDOW & EXTERIOR DOOR SCHEDULE

- CONCRETE FLOOR SLAB (R-31)

 4* POLISHED CONCRETE SLAB

 15 MIC TO/ FADOR NATE D (ARIVADOUR) BARRIER ALL

 05 SEALED

 05 SEALED

 07 2027 TYPE 2 EPS FOAM

 0* CRUSHED DRAIN ROCK

 0* CRUSHED DRAIN ROCK
 GARAGE / SCREENED PORCH FLOOR SLAB (R-11) TILES (SCREENED PORCH ONLY) 4' CONCRETE SLAB 6 MIL POLY (ARRVAPOR BARRIER) ALL JOINTS SEALED 21/27 TYPE / DES FORA 6' UNDISTURBED SOILCOMPACTED STRUCTURAL FILL F2
- W1 FOUNDATION WALL (R-17) 1 1/2" TYPE 2 EPS INSIDE 2 1/2" TYPE 2 EPS INSIDE 8" CONCRETE DAMP PROOFING AS REQUIRED EXTERIOR FINISH T.B.D.
- W2 PORCH / GARAGE FOUNDATION WALL 8" CONCRETE DAMP PROOFING AS REQUIRED
- W3 EXTERIOR DOUBLE STUD WALL (R-44) 249 DRYNALC 254 STUDE WI TGHT FITTING R-12 BATT INSULATION, 24° O.C. 254 STUDE WI TGHT FITTING R-12 BATT INSULATION, 24° O.C. 11/27 NON PERFORATED FOLL FACED POLYISOS (AIRWAPOUR BARRIER) (ALL SEAMS ARI SEALED) 278 STRUCTURAL STUDES WI 2 LAYER TIGHT-FITTING R-12 BATT INSULATION, 24° O.C. 716° OSB OR EQ. PLYWOOD SHEATHING WRR WRB SIDING AS SHOWN ON ELEVATIONS
- W4 EXTERIOR 2X6 WALL PORCH / GARAGE (R-22) INTERIOR FINISH TBD 6MIL POLY (AIR/VAPOUR BARRIER) 2X6 STUDS WI TIGHT-FITTING R-20 BATT INSULATION, 24" O.C. 7/16" OSB WALL SHEATHING OR EQ. SIDING AS SHOWN ON ELEVATIONS
- ROOF OVER HOUSE (R-92) 1/2* DERVWALL 2X STRAPPING, 16* 0.C. INTELLO PLUS AIRVAPOUR BARRIER, ALL JOINTS SEALED ENSIMERERE DWOOT TRUSSES, W. 26* CELLULOSE INSULATION, SLOPES AND OVERHANG AS SHOWN ON LEWITONE DAR SPACE 5/8* 058 ROOF SHEATHING W H-CLIPS OR EQ. METAL ROOF ING W UNDERLAY AS PER MANU. INSTRUCTIONS R1
- R2 ROOF OVER PORCH/GARAGE (R-22) CEILING FINISH T.B.D. CEILING FINISH T.B.D. GMIL POLY VAPOUR BARRIER 1X4 STRAPPING 16" O.C. PRE-ENGINEERED WOOD TRUSSES W/ INSULATION 58" COSE SHEATHING W/ H-CLIPS OR EQ. METAL ROOFING W/ UNDERLAY AS PER MANU. INSTRUCTIONS

ASSEMBLY NOTES


- All exterior finish materials and colours are noted on elevations; special interior finishes are noted on the floor plans.
- For durability, the builder must achieve an aritightness of 75 ACH or better at 50 Pa. Perform a blower-door test after all rough-ins and prior to final insulating in order to confirm this airtightness and to remedy any problems at that time.
- Main air-sealing materials are to be the foil faced rigid insulation layer on exterior walls, the Intello Plus layer on underside of roof trusses, and the 15 mil sub slab poly which together should form a continuous envelope.Seal foil faced rigid insulation with air sealing tape. Seal 15mil poly with manufacturers recommended product. For taping seams in intello membrane, use manufacturers recommended tapes and seale
- Tape for sealing joints, service penetrations, etc., to be either 3M 8067 or 3015 All-Weather Flashing Tape. Ensure surfaces are dry before applying and caulk all seams with acoustical sealant prior to applying
- Use min 3" widths of tape for flat seams. For air-sealing corners and other non-flat seams use wide enough tape that it covers 1.5" onto the flat of the main air-barrier sheets.
- 3M 8067 and 3M 3015 tape are to be considered interchangable on this project. All other tape substitutions must be confirmed with the designer.
- Where required, frost walls and non-structural slabs on grade are to use Type 2 EPS
- Install foam sill gasket under all wood in contact with concrete surfaces, including all plates and columns.
- For taping weather barrier membrane and other membrane materials, use the product recommended by the manufacturer.
- Ensure foundation foam is covered as required to protect against intrusions by ants and termites as per local best-practices.
- Use galvanized foundation flashing or parging to cover exposed portions of foundation foam insulation. If using galvanized flashing: 26 ga. custom bend to fit, min 4" up wall, 10" down foam. Overlap joints min 4" and w/ 2-"10 stainless screws at all joints
- 12. Testing of insulation coverage with IR camera is recommended 13 A rainsreen is required behind all types of siding unless noted otherwise
- 14. Where frost walls or basement foundation walls are present on plan, foundation wall damp proofing and footer drainage is to meet local building code and site groundwater conditions as required
- 15. Assembly R-values shown are "center of cavity" values.

Image as viewed		Door S Window Si	ab or Frame ze	Sash	Head	
from exterior	Mark	Width	Height	Operation	Height (AFF)	Comments
	А	3'0*	6'8"	Swing Simple		tiple pane glass, multipoint hardware
Œ						
	в	2'10"	6'8"	Swing Simple		accesible sill, self closing hinge, deadbolt
HEF						
Č.						
	с	2"10"	6'8"	Swing Simple		deadbolt
						triple pane full glass,
	D	2'10"	6'8"	Swing Simple		multipoint hardware.
		210	6.8	Simple		accesible sill
K .						
Ľ	Е	2'10"	6'8"	Swing Simple		double pane full glass, deadbolt
	<u> </u>	2.0		Carliple		
	GW 14	7'0"	2'6"	Custom	6'10"	Double glazed only - garage window
	W.01	4'6*	3'0"	Fixed Glass	6'10"	
	W 02	7'0*	3'0"	Custom	6'10"	2'4" right casement
	W 03	2'6"	3'0"	Casement	6'10"	
	W.04	5'0*	4'0"	Custom	6'10"	
	W 05	5'0"	4'0"	Custom	6'10"	
	W 06	5'8*	4'0"	Custom	6'10"	
	W 07	2'10"	4'0"	Casement	6'10"	
		2.0		- aboment		
	W.08	5'8"	4'0"	Custom	6'10"	
	W 10	5'0*	4'6"	Custom	6'10"	
	W.11	5'8"	5'0"	Custom	6'10"	
للمسالمسا	W.12	5'8"	5'0"	Custom	6'10"	
	W 13	5'8"	5'0"	Custom	6'10"	

INTERIOR DOOR SCHEDULE

	Nominal Size				
Mark	Width	Height	Door Operation	Slab Style	Comments
а	6'0"	6'8"	Slider	Solid	
b	3'0"	6'8"	Swing Simple	Solid	
с	3'0"	6'8"	Swing Simple	Solid	
d	3'0"	6'8"	Swing Simple	Solid	
е	8'0"	6'8"	Slider	Solid	3 DOORS
f	3'0"	6'8"	Swing Simple	Solid	
a	3'0"	6'8"	Swing Simple	Solid	GLASS OPTIONAL
h	3'0"	6'8"	Swing Simple	Solid	
I	3'0"	6'8"	Swing Simple	Solid	STC 50, GLASS OPTIONAL
1	3'0"	6'8"	Swing Simple	Solid	STC 50

GENERAL SYMBOLS LEGEND

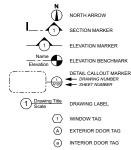

4

brickmoulds.

ASSEMBLY CALLOUT MARKER

ABBREVIATIONS LIST

- Audio Video Air Changes per Hour Above Finished Foor Demostle Hot Water Ductiess Minr-Split Down Expanded Polystyrene Extension Gypeum Wall Board Gypeum Wall Board Healt Recovery Vertilator Including Laminated Veneer Lumber Manufactures Not Required Overall

- A/V ACH AFF C/L DHW DMS DN EPS EQ. Ext. FD GWB HRV ICF GWB HRV ICF INS. LVL Min. N/R O.C. O/SB P.T. O SBB P.T. T.J. T.J. T.J.

- Typ. Sim. SOG Spec SS U/S W/ WC WRB XPS
- With
- Specifications Stainless Steel Under Side Water Closet
- Not Required Overall On Center Outside Oriented Strand Board Pressure Treated Rough Stud Opening Tongue And Groove To Be Confirmed To Be Determined Fonineered Wonden L1
- Engineered Wooden I Joist Top Of
- Typical Similar Slab On Grade

Weather Resistive Barrier Extruded Polystyrene

- Distantional (by manu).
 16. Exterior siding patio doors are to have threshold extensions as req'd to match brickmould (by manu.)
 16. If present, exterior double swing doors are to have one swing and one fixed panel as shown.
 17. If using a custom painted entry door slab, manufacturer to include a

WINDOW/DOOR SCHEDULE NOTES

Window dimensions are to exterior frame.
 Al window Kohltech Suprema 2520 with Energlass Plus triple glazing or approved eq. Fixed windows are to have picture narrow profile, no steel reinforcing.
 Window substitutions are to meet these minimum requirements (imperail) controling with or exceeding minimums laid out in sections 9.7 and SB-12 of the OBC: Frame: 31 44 Web, max: U.0.20 Glass: max: U.0.14, mm. SHGO.0.80 Glassers max: U.0.167 dhoust heat meet land and lands:

Windows to have 1/2" drywall returns at head and jambs, 3/4" trim return for a durable hard surface at sill.

Confirm trim and grill options with Owner prior to finalizing order.

Kohltech exterior doors with Energlass Plus triple glazed and multi-point latching or approved eq.
 Door substitutions are to meet these requirements (imperial):

Door slab: max. U 0.20 Glass: max. U 0.14, min. SHGC 0.60 with warm-edge spacer Glazing spacer PSI: 0.015 Thermally broken sill

Use manufacturer brickmoulds for exterior swing doors, width to match windows and confirmed by owner.

Exterior swing doors are to have threshold extensions as req'd to match brickmould (by manu.)

6. Owner is to confirm colour for all window and door frames and

Windows and doors are to use stainless steel hardware Ensure bedrooms conform with code fire earess requirements. Windows are to include heavy duty bug screen 10. Door dimensions are for door slab.

Window dimensions are to exterior frame

- construction door slab to avoid damages to paint. 18. If present, confirm patio door threshold before placing order.
- If required, include self-closing hinges and air-tight weatherstripping for doors between the house and garage.
- In case of any discrepancy between casement window or door swings shown on the floor plans and on the window schedule, the floor plan will have authority.
- 21. See framing plan(s) for window and door rough stud opening table and RSO framing notes.
- Screen porch windows are to be double glazed with sizes as noted on framing plan.
 Interior door slab, hardware, trim, and all other features are to be selected by Owner.
- 24. Allow 4" min for interior trim around interior doors. Builder to confirm all door openings and trim allowances prior to interior door orde



GENERAL NOTES

- 1. All work is, at a minimum, to be completed in accordance with the National Building Code of Canada, latest edition, and in accordance with all other applicable codes, bylaws, and other legal requirements.
- 2. All Federal, Provincial, and local ordinances, etc., shall be considered as part of the specifications for this building and shall take precedence over anything shown, described, or implied, if and when variances occur.
- 3. The Builder is to check and verify all drawings for compliance with local building and zoning requirements and report any discrepancies prior to commencing construction.
- 4. Structural lumber is to be No. 2 SPF or better, or the equivalent manufactured lumber product. 5. Design and engineering of manufactured wood structural members.
- including floor joists, roof trusses, beams, columns, and lintels, to be by supplier.
- 6. This drawing does not take into account unknown site conditions such as soil bearing capacity, water tables, depth of bedrock, buried structures, etc.
- 7. Remove all demolition debris and construction waste from the site except material and items specifically noted by the Owner to be left on site. Job site is to be left broom clean when the contract is complete.
- 8. Structural engineering if required, by others. © Passive Design Solutions

Designs and drawings are the exclusive

copyright of PDS. The drawings cannot be reproduced, modified, reused, published, presented or shared in any part or whole without written consent from PDS. Purchase of a plan set from PDS, provides a non-exclusive right to build a single home. Building more than one home is an infringement of the Copyright Act.

Barb and Don Mason

MEADOW

Hebb Point Rd., Lunenburg NS 60404191

DESIGN DOCUMENTS ISSUED FOR CONSTRUCTION


Tuesday, May 24, 2022


Sc	hed	lules
----	-----	-------


ZA Checked By: Drawn By:

XX

A001

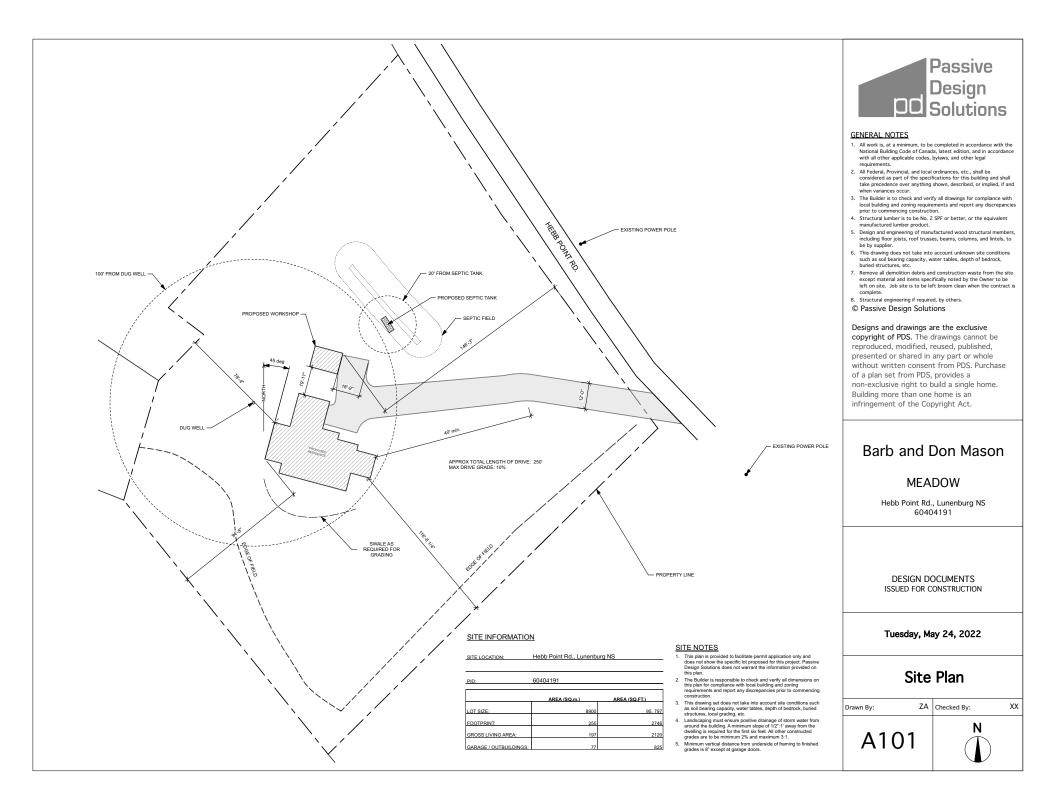

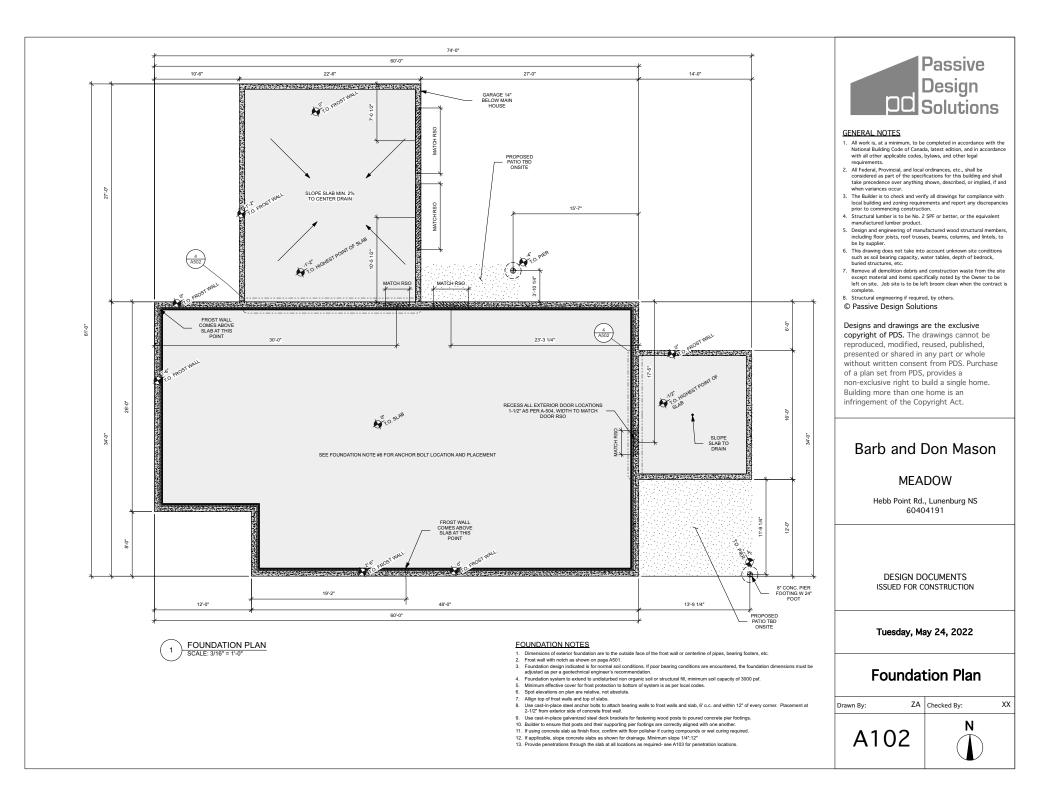

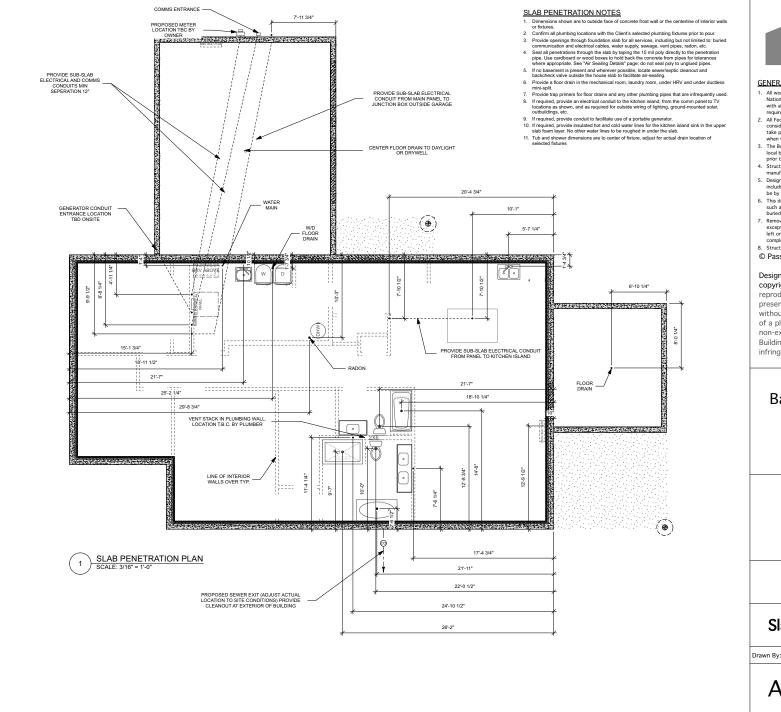



GENERAL NOTES

- 1. All work is, at a minimum, to be completed in accordance with the National Building Code of Canada, latest edition, and in accordance with all other applicable codes, bylaws, and other legal requirements.
- 2. All Federal, Provincial, and local ordinances, etc., shall be considered as part of the specifications for this building and shall take precedence over anything shown, described, or implied, if and when variances occur.
- 3. The Builder is to check and verify all drawings for compliance with Incal building and zong requirements and report any discrepancies prior to commencing construction.
 Structural lumber is to be No. 2 SPF or better, or the equivalent
- manufactured lumber product.
- 5. Design and engineering of manufactured wood structural members including floor joists, roof trusses, beams, columns, and lintels, to be by supplier.
- 6. This drawing does not take into account unknown site conditions such as soil bearing capacity, water tables, depth of bedrock, buried structures, etc.
- 7. Remove all demolition debris and construction waste from the site except material and items specifically noted by the Owner to be left on site. Job site is to be left broom clean when the contract is complete.
- 8. Structural engineering if required, by others. © Passive Design Solutions

Designs and drawings are the exclusive

copyright of PDS. The drawings cannot be reproduced, modified, reused, published, presented or shared in any part or whole without written consent from PDS. Purchase of a plan set from PDS, provides a non-exclusive right to build a single home. Building more than one home is an infringement of the Copyright Act.

Barb and Don Mason

MEADOW


Hebb Point Rd., Lunenburg NS 60404191


DESIGN DOCUMENTS ISSUED FOR CONSTRUCTION

Tuesday, May 24, 2022

Slab Penetration Plan

ZA Checked By: XX Ν A103

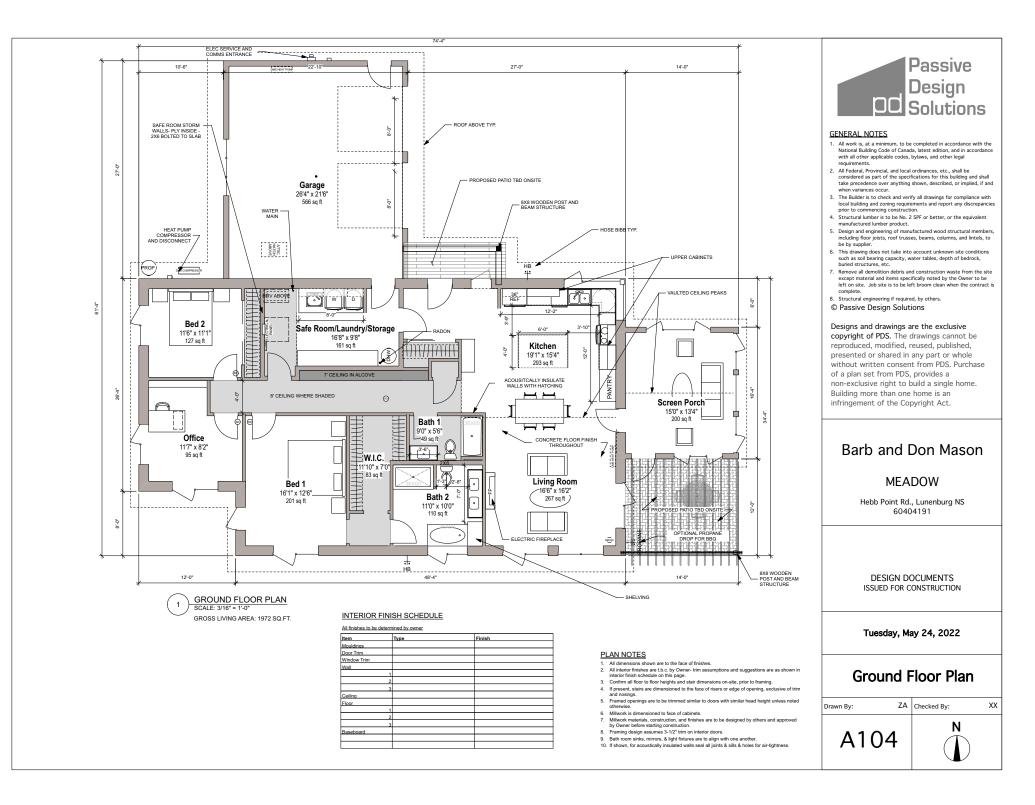

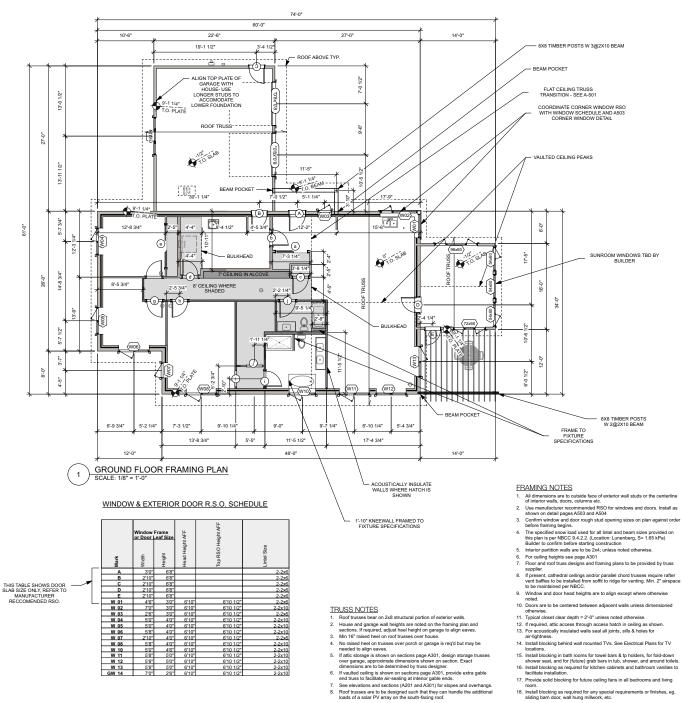



- 1. All work is, at a minimum, to be completed in accordance with the National Building Code of Canada, latest edition, and in accordance with all other applicable codes, bylaws, and other legal requirements.
- 2. All Federal, Provincial, and local ordinances, etc., shall be considered as part of the specifications for this building and shall take precedence over anything shown, described, or implied, if and when variances occur.
- 3. The Builder is to check and verify all drawings for compliance with local building and zoning requirements and report any discrepancies
- prior to commencing construction. 4. Structural lumber is to be No. 2 SPF or better, or the equivalent manufactured lumber product.
- 5. Design and engineering of manufactured wood structural members including floor joists, roof trusses, beams, columns, and lintels, to be by supplier.
- 6. This drawing does not take into account unknown site conditions such as soil bearing capacity, water tables, depth of bedrock, buried structures, etc.
- 7. Remove all demolition debris and construction waste from the site except material and items specifically noted by the Owner to be left on site. Job site is to be left broom clean when the contract is complete.
- 8. Structural engineering if required, by others. © Passive Design Solutions

Designs and drawings are the exclusive

copyright of PDS. The drawings cannot be reproduced, modified, reused, published, presented or shared in any part or whole without written consent from PDS. Purchase of a plan set from PDS, provides a non-exclusive right to build a single home. Building more than one home is an infringement of the Copyright Act.

Barb and Don Mason

MEADOW

Hebb Point Rd., Lunenburg NS 60404191

DESIGN DOCUMENTS

ISSUED FOR CONSTRUCTION

Tuesday, May 24, 2022

Ground Floor Framing

Plan

Drawn By:

A105

ZA Checked By:

Ν

ΧХ

- 3. Confirm window and door rough stud opening sizes on plan against order
- If present, cathedral ceilings and/or parallel chord trusses require rafter
- 10. Doors are to be centered between adjacent walls unless dimensioned
- 14. Install blocking behind wall mounted TVs. See Electrical Plans for TV



GENERAL NOTES

- All work is, at a minimum, to be completed in accordance with the National Building Code of Canada, latest edition, and in accordance
- Nethon and the second secon
- prior to commencing construction. 4. Structural lumber is to be No. 2 SPF or better, or the equivalent
- Structural lumber is to be No. 2 SPF or better, or the equivalent manufactured lumber product.
 Design and engineering of manufactured wood structural members, including floor joists, roof trusses, beams, columns, and lintels, to
- be by supplier. 6. This drawing does not take into account unknown site conditions
- This drawing does not take into account unknown site conautions such as soil bearing capacity, water tables, depth of bedrock, buried structures, etc.
 Remove all demolition debris and construction waste from the site except material and items specifically noted by the Owner to be
- left on site. Job site is to be left broom clean when the contract is 8. <u>Strugteral</u> engineering if required, by others.

© Passive Design Solutions

Designs and drawings are the exclusive copyright of PDS. The drawings cannot be reproduced, modified, reused, published, presented or shared in any part or whole without written consent from PDS. Purchase of a plan set from PDS, provides a non-exclusive right to build a single home. Building more than one home is an infringement of the Copyright Act.

Barb and Don Mason

MEADOW

Hebb Point Rd., Lunenburg NS 60404191

DESIGN DOCUMENTS ISSUED FOR CONSTRUCTION

Tuesday, May 24, 2022

Roof Plan

ΧХ


Ν

- 3. Min 16" raised heel on roof trusses over house. No raised heel on trusses over porch or garage is req'd but may be needed to align eaves.
- If attl: storage is shown on sections page A301, design storage trusses over garage, approximate dimensions shown on section. Exact dimensions are to be determined by truss designer.
 If vaulted ceiling is shown on sections page A301, provide extra gable end truss to facilitate air-sealing at interior gable ends.

Roof trusses bear on 2x8 structural portion of exterior walls.
 House and garage wall heights are noted on the framing plan and sections. If required, adjust heel height on garage to align eaves.

TRUSS NOTES

- See elevations and sections (A201 and A301) for slopes and overhangs. Roof trusses are to be designed such that they can handle the additional loads of a solar PV array on the south-facing roof.

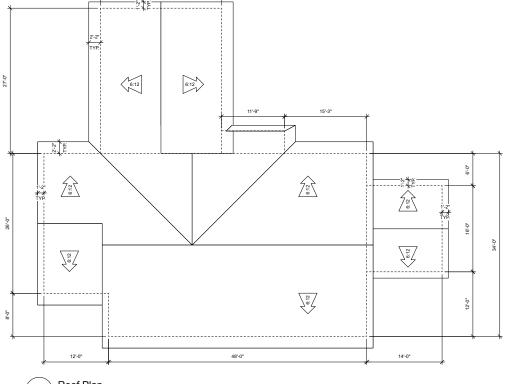

22'-6"


Roof Plan Scale: 1/8" = 1'-0"


1

PLAN NOTES


- All dimensions shown are to outer edge of wall framing below
- Plumbing vent stack/s to be located on north facing roof to avoid interfering with solar panel array
- 3. Roof finish is as per finish schedule on A201
- Roof overhang dimensions measure from the outer face of wall framing to outer face of fascia
- 5. Roof truss layout is by supplier

LM Checked By: Drawn By: A106

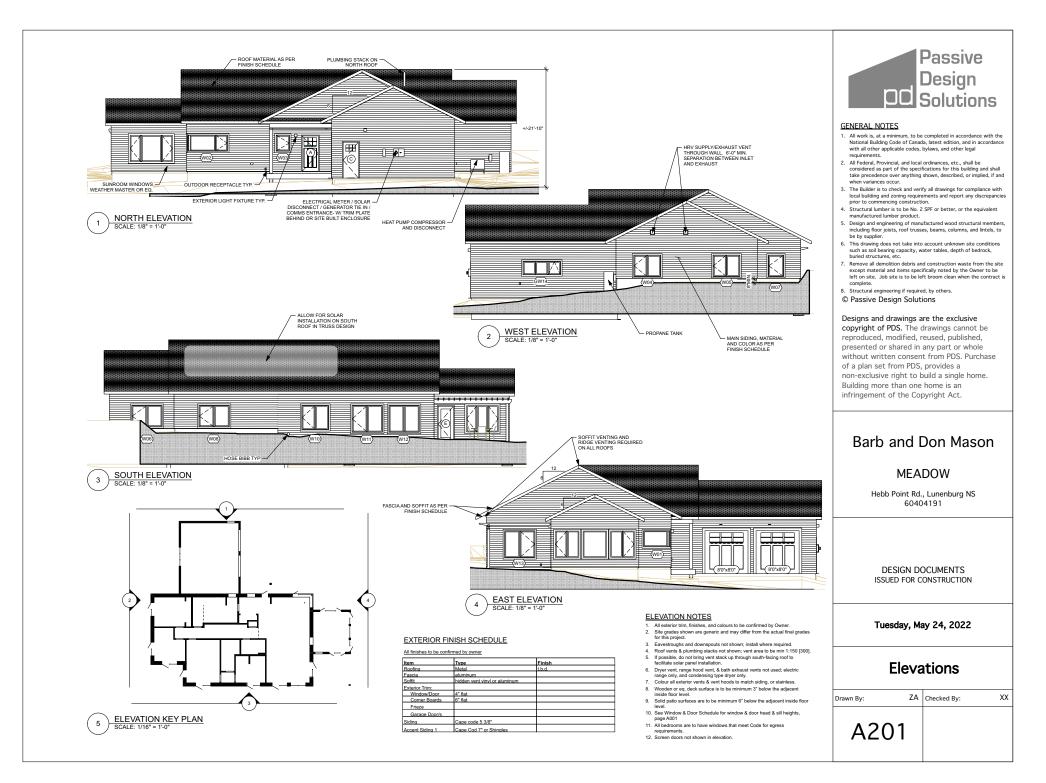


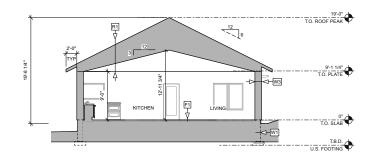

TRANSVERSE SECTION 1 1 SCALE: 1/8" = 1'-0"

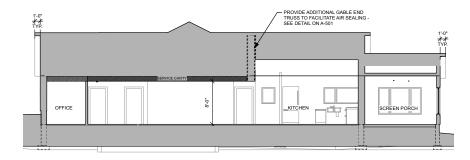


LONGITUDINAL SECTION 1 3 SCALE: 1/8" = 1'-0"

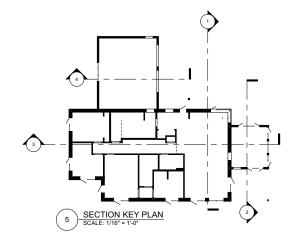




TRANSVERSE SECTION 2 SCALE: 1/8" = 1'-0" 2

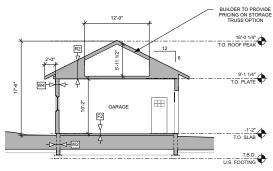

TRANSVERSE SECTION 3 4 SCALE: 1/8" = 1'-0'

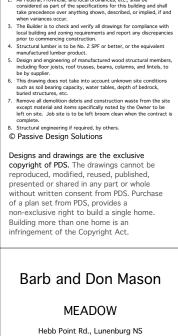

DESIGN DOCUMENTS ISSUED FOR CONSTRUCTION Tuesday, May 24, 2022 Sections ZA Checked By: ΧХ Drawn By: A301

Design **Solutions**


Passive


GENERAL NOTES

- 1. All work is, at a minimum, to be completed in accordance with the National Building Code of Canada, latest edition, and in accordance with all other applicable codes, bylaws, and other legal requirements.
- 2. All Federal, Provincial, and local ordinances, etc., shall be considered as part of the specifications for this building and shall take precedence over anything shown, described, or implied, if and

60404191

- SECTION NOTES
- If shown, confirm vertical dimensions after pre-engineered floor truss sizes are established. See Window & Door Schedule for window & door head & sill heights,
- Site grades shown are generic and may differ from the actual final grades for this project.
- to use project.
 4. Landscaping must ensure positive drainage of storm water from around the building. A minimum slope of 1/2':1' away from the dwelling is required for the first six feet. All other constructed grades are to be minimum 2% and maximum 3:1.
- Wooden or eq. deck surface is to be minimum 3" below the adjacent inside floor level.
- 6. Solid patio surfaces are to be minimum 6" below the adjacent inside floor level
- Stope exterior patios and solid surface decks to drain 1/4" per 1'-0" for 10" around house.
- Garage and porch slabs to be minimum 1/2" below the adjacent inside floor level

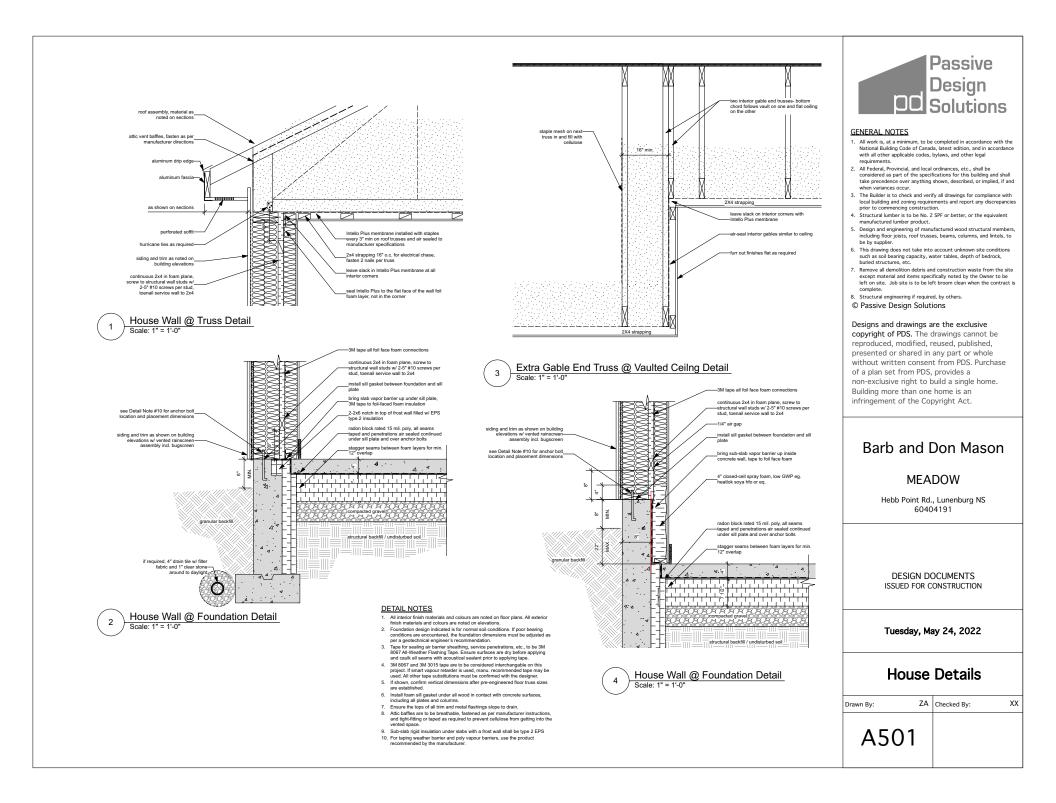

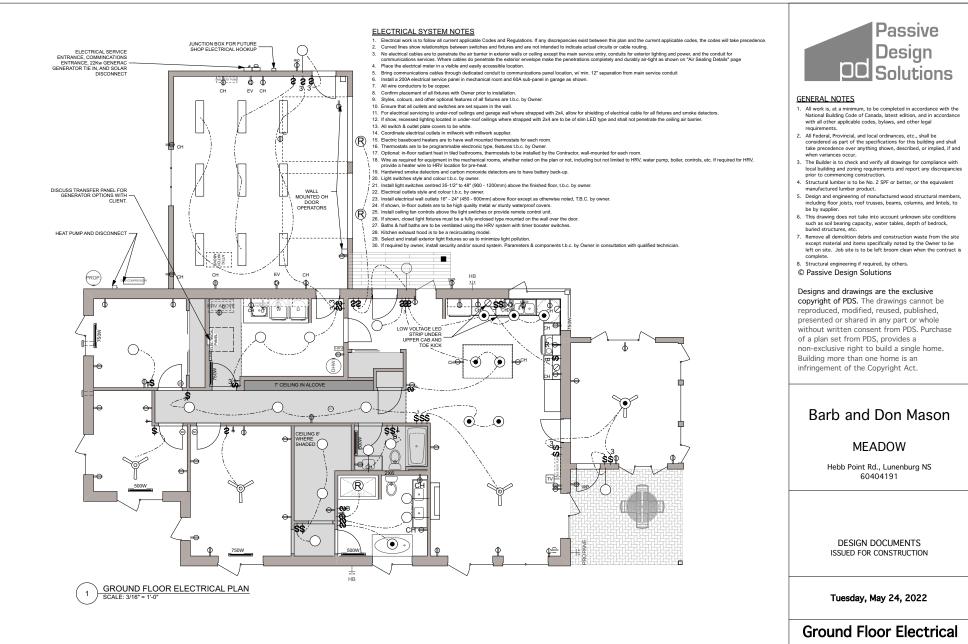

Plan

Drawn By:

E101

ZA Checked By:

Ν

ΧХ

SOLAR ROUGH IN:

- Discuss solar array options with Owner and determine if ground-mounted or roof-mounted array is more desirable for this particular site.
 Install disconnect for solar array beside electrical meter.
- Install cable and/or conduits to outside ground from solar array location
- Install cable and/or conduit from service panel to solar array
- location.
- If required, coordinate install of storage batteries and other off-grid components.

